


BURTON CHACE PARK, MARINA DEL REY SIDEWALK REPLACEMENT PLAN

SCALE: 1" = 50'



SIDEWALK REPLACEMENT AREA (SF) ITEM 12,500 PEDESTRIAN PAVERS

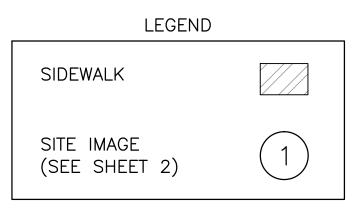

		NOBLE CONSULTANTS, INC.
--	--	-------------------------

2201	DUPONT DRIVE, SUITE 830	
2201	<i>'</i>	
	IRVINE, CA. 92715	
	949-752-1530	
	949-752-8381 (FAX)	

10.	DATE	REVISION	DESIGNED BYJLR	COUNTY OF LOS ANGELES - DEPARTMENT OF BEACHES AND HARBORS SH	неет 1 ог 3
			DRAWN BY	Jo	ов но. 928-59
			CHECKED BYRMN	SIDEWALK REPLACEMENT PLAN	PEC. NO. AS SHOWN
			APPROV. BYRMN	CHACE PARK ANCHORAGE 47 DOCK REPLACEMENT	ATE 03 JAN. 2013



1 TYPICAL SIDEWALK




TYPICAL SIDEWALK




3 TYPICAL SIDEWALK




TYPICAL SIDEWALK

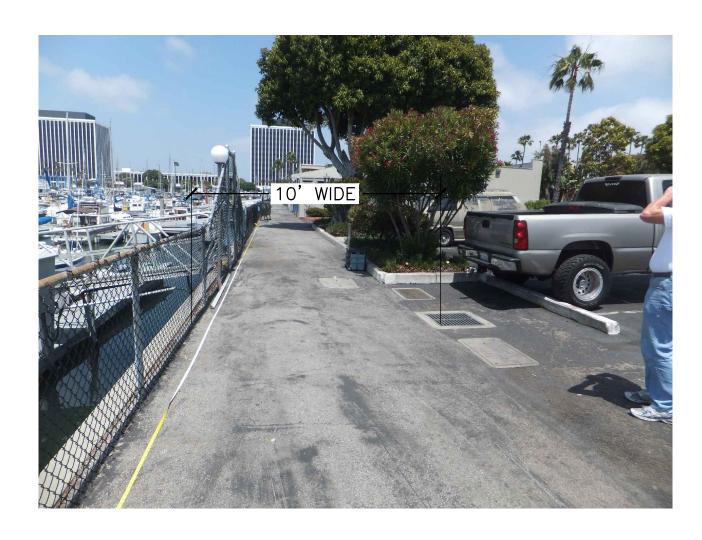

5 TYPICAL SIDEWALK

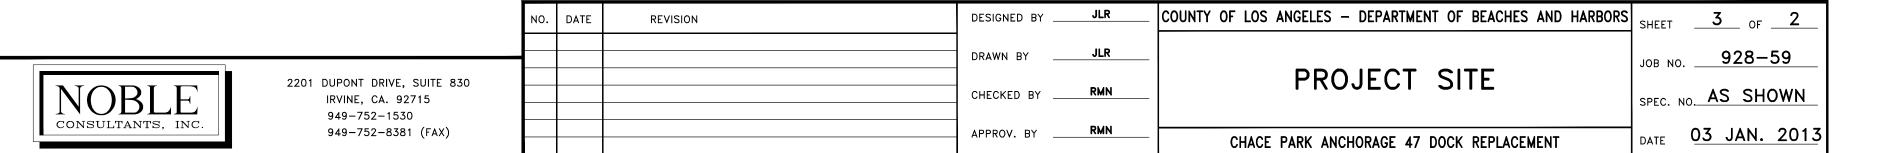

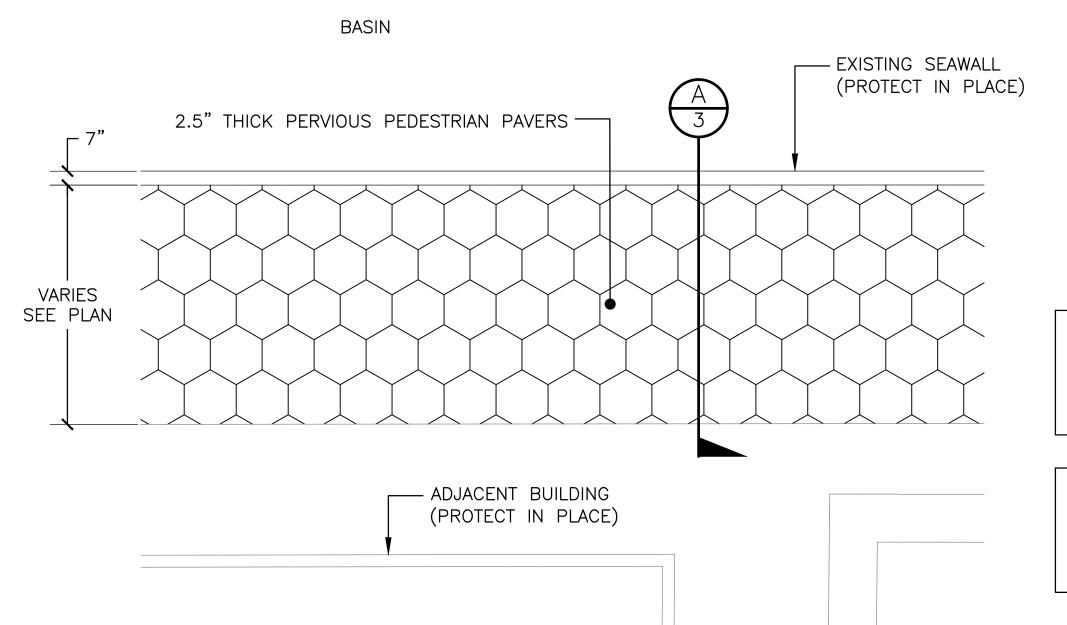


FURNISH AND COMPACT CLASS 2 AGGREGATE BASE AS REQUIRED TO ATTAIN PAVERS FLUSH WITH TOP OF SEAWALL ELEVATION.

FIELD VERIFY PAVEMENT GRADES AND ADJUST SLOPES AS REQUIRED FOR DRAINAGE TO MATCH EXISTING GRADES AT SAW CUT LIMIT LINES.

SIDEWALK WITH PAVERS DETAIL PLAN VIEW

SCALE: 1" = 4'



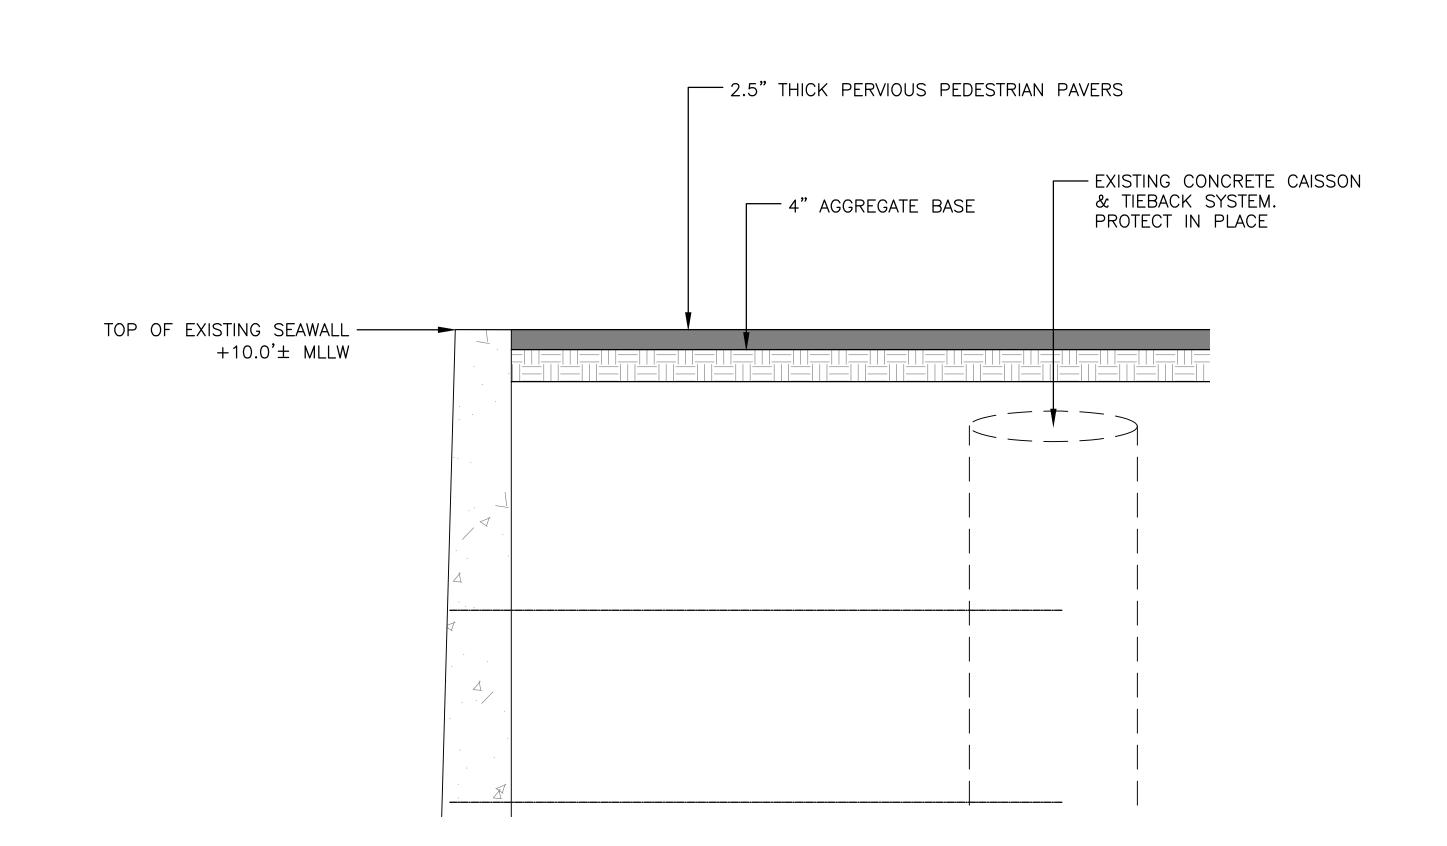


SIDEWALK WITH PAVERS SECTION VIEW

3 SCALE: 1" = 1'





3 PEDESTRIAN PAVER EXAMPLE PHOTO 3 SCALE: N/A

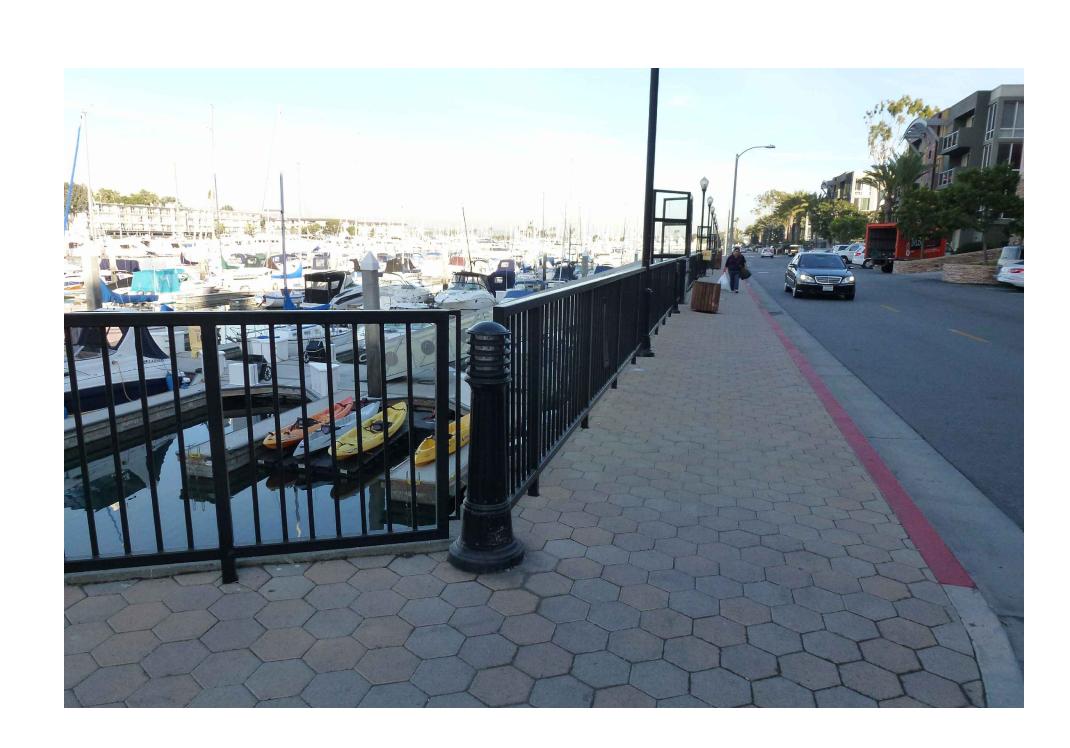



4 PEDESTRIAN PAVER EXAMPLE PHOTO 3 SCALE: N/A

	NO.	DATE	REVISION	DESIGNED BYJLR	COUNTY OF LOS ANGELES - DEPARTMENT OF BEACHES AND HARBORS	SHEET	<u> </u>	_F 3
				DRAWN BYJLR		JOB NO.	928	-59
NOBLE 2201 DUPONT DRIVE, SUITE 830 IRVINE, CA. 92715				CHECKED BY RMN	SIDEWALK DETAILS	SPEC. N	o. AS SI	<u>HOWN</u>
949-752-1530 CONSULTANTS, INC. 949-752-8381 (FAX)				APPROV. BYRMN	CHACE PARK ANCHORAGE 47 DOCK REPLACEMENT	DATE	03 JAN	. 201

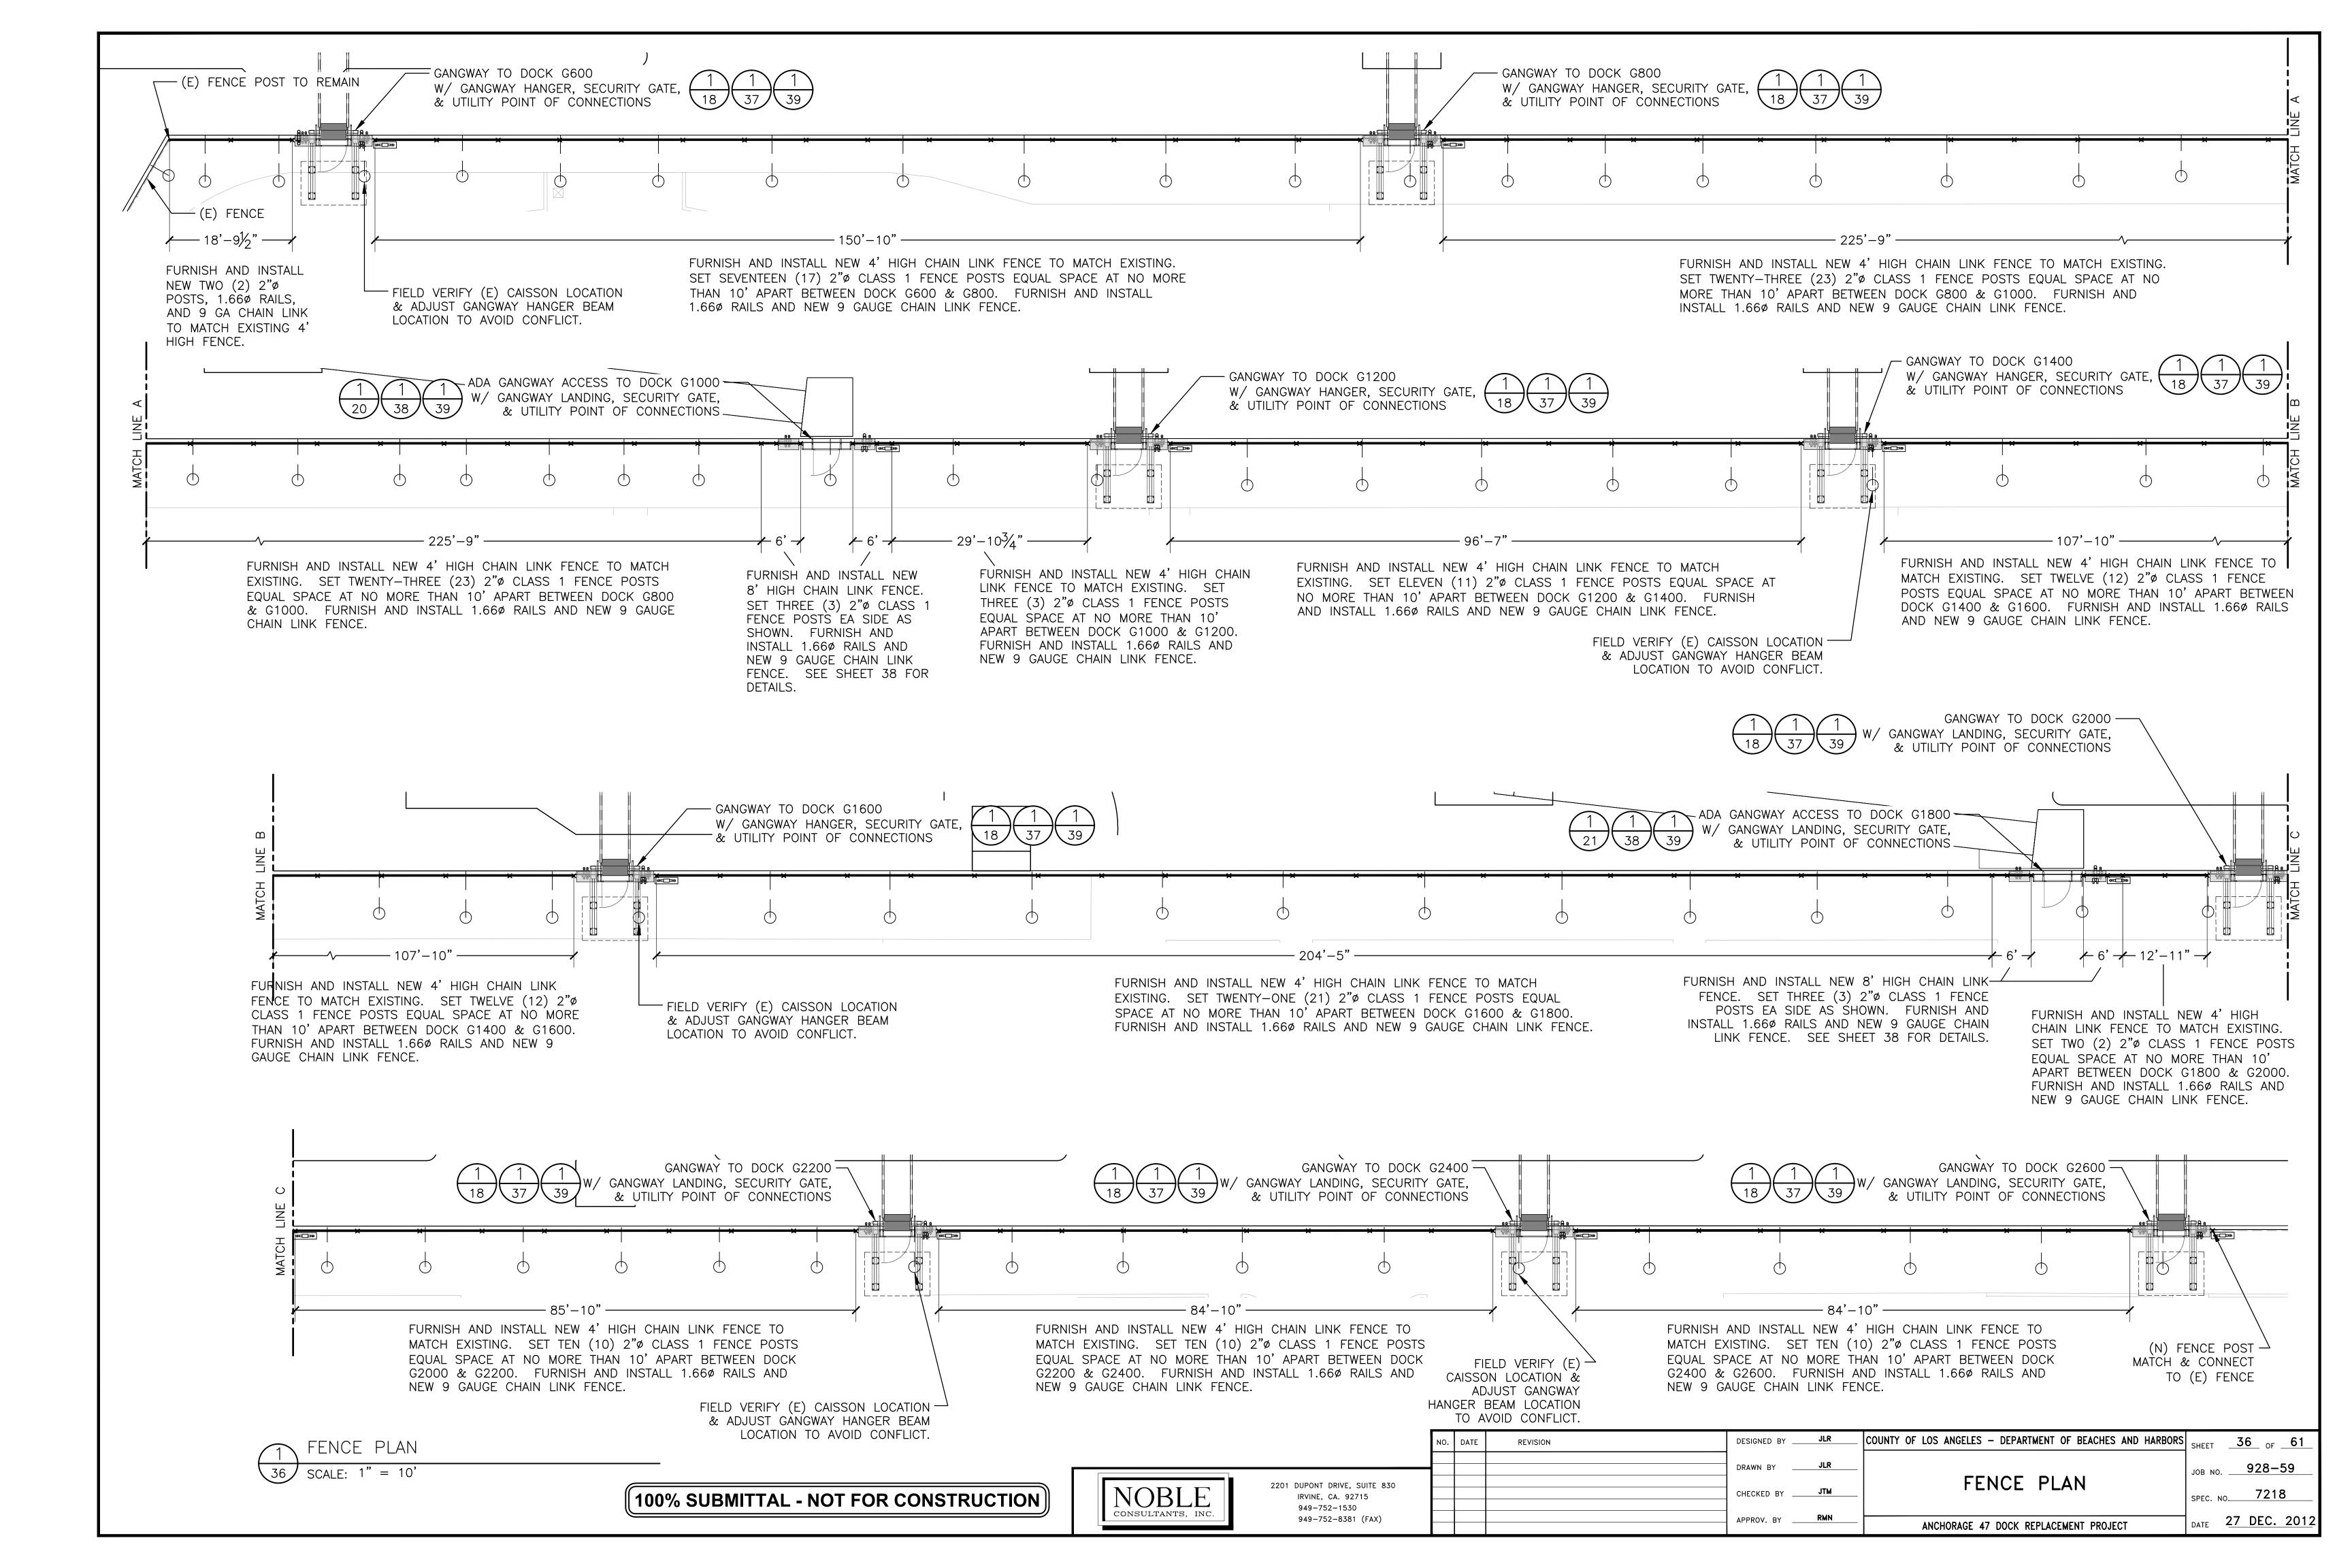

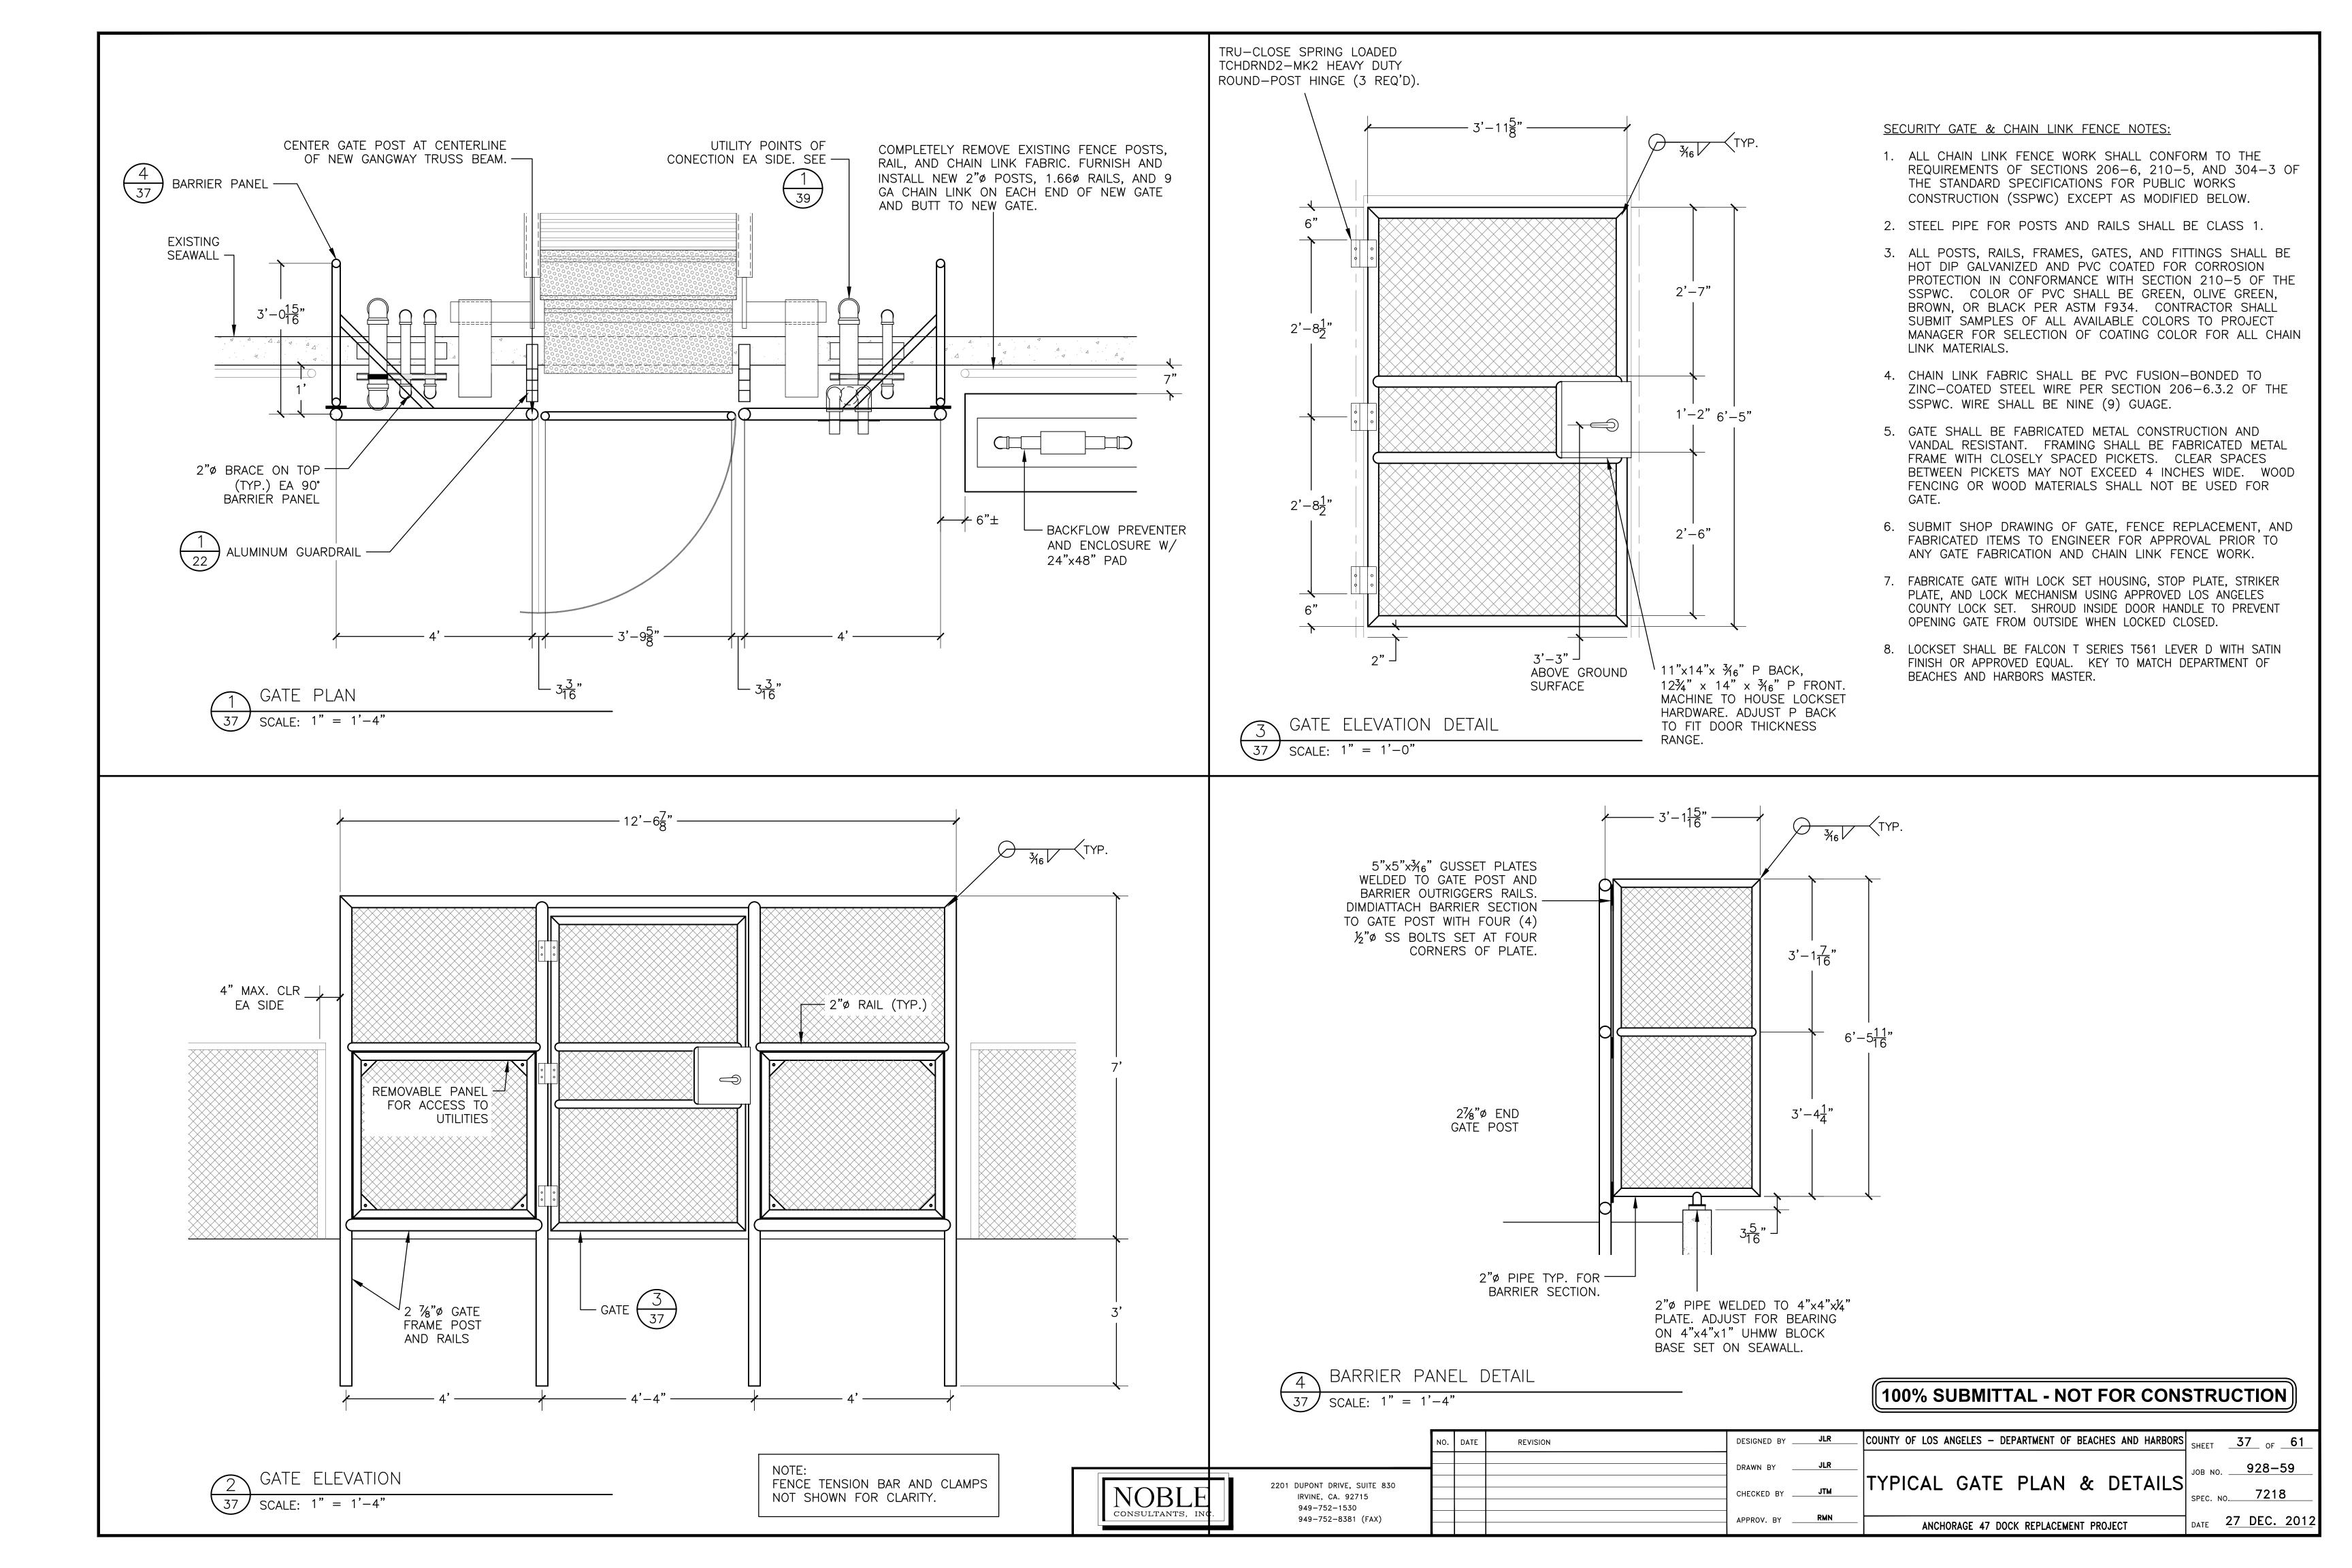

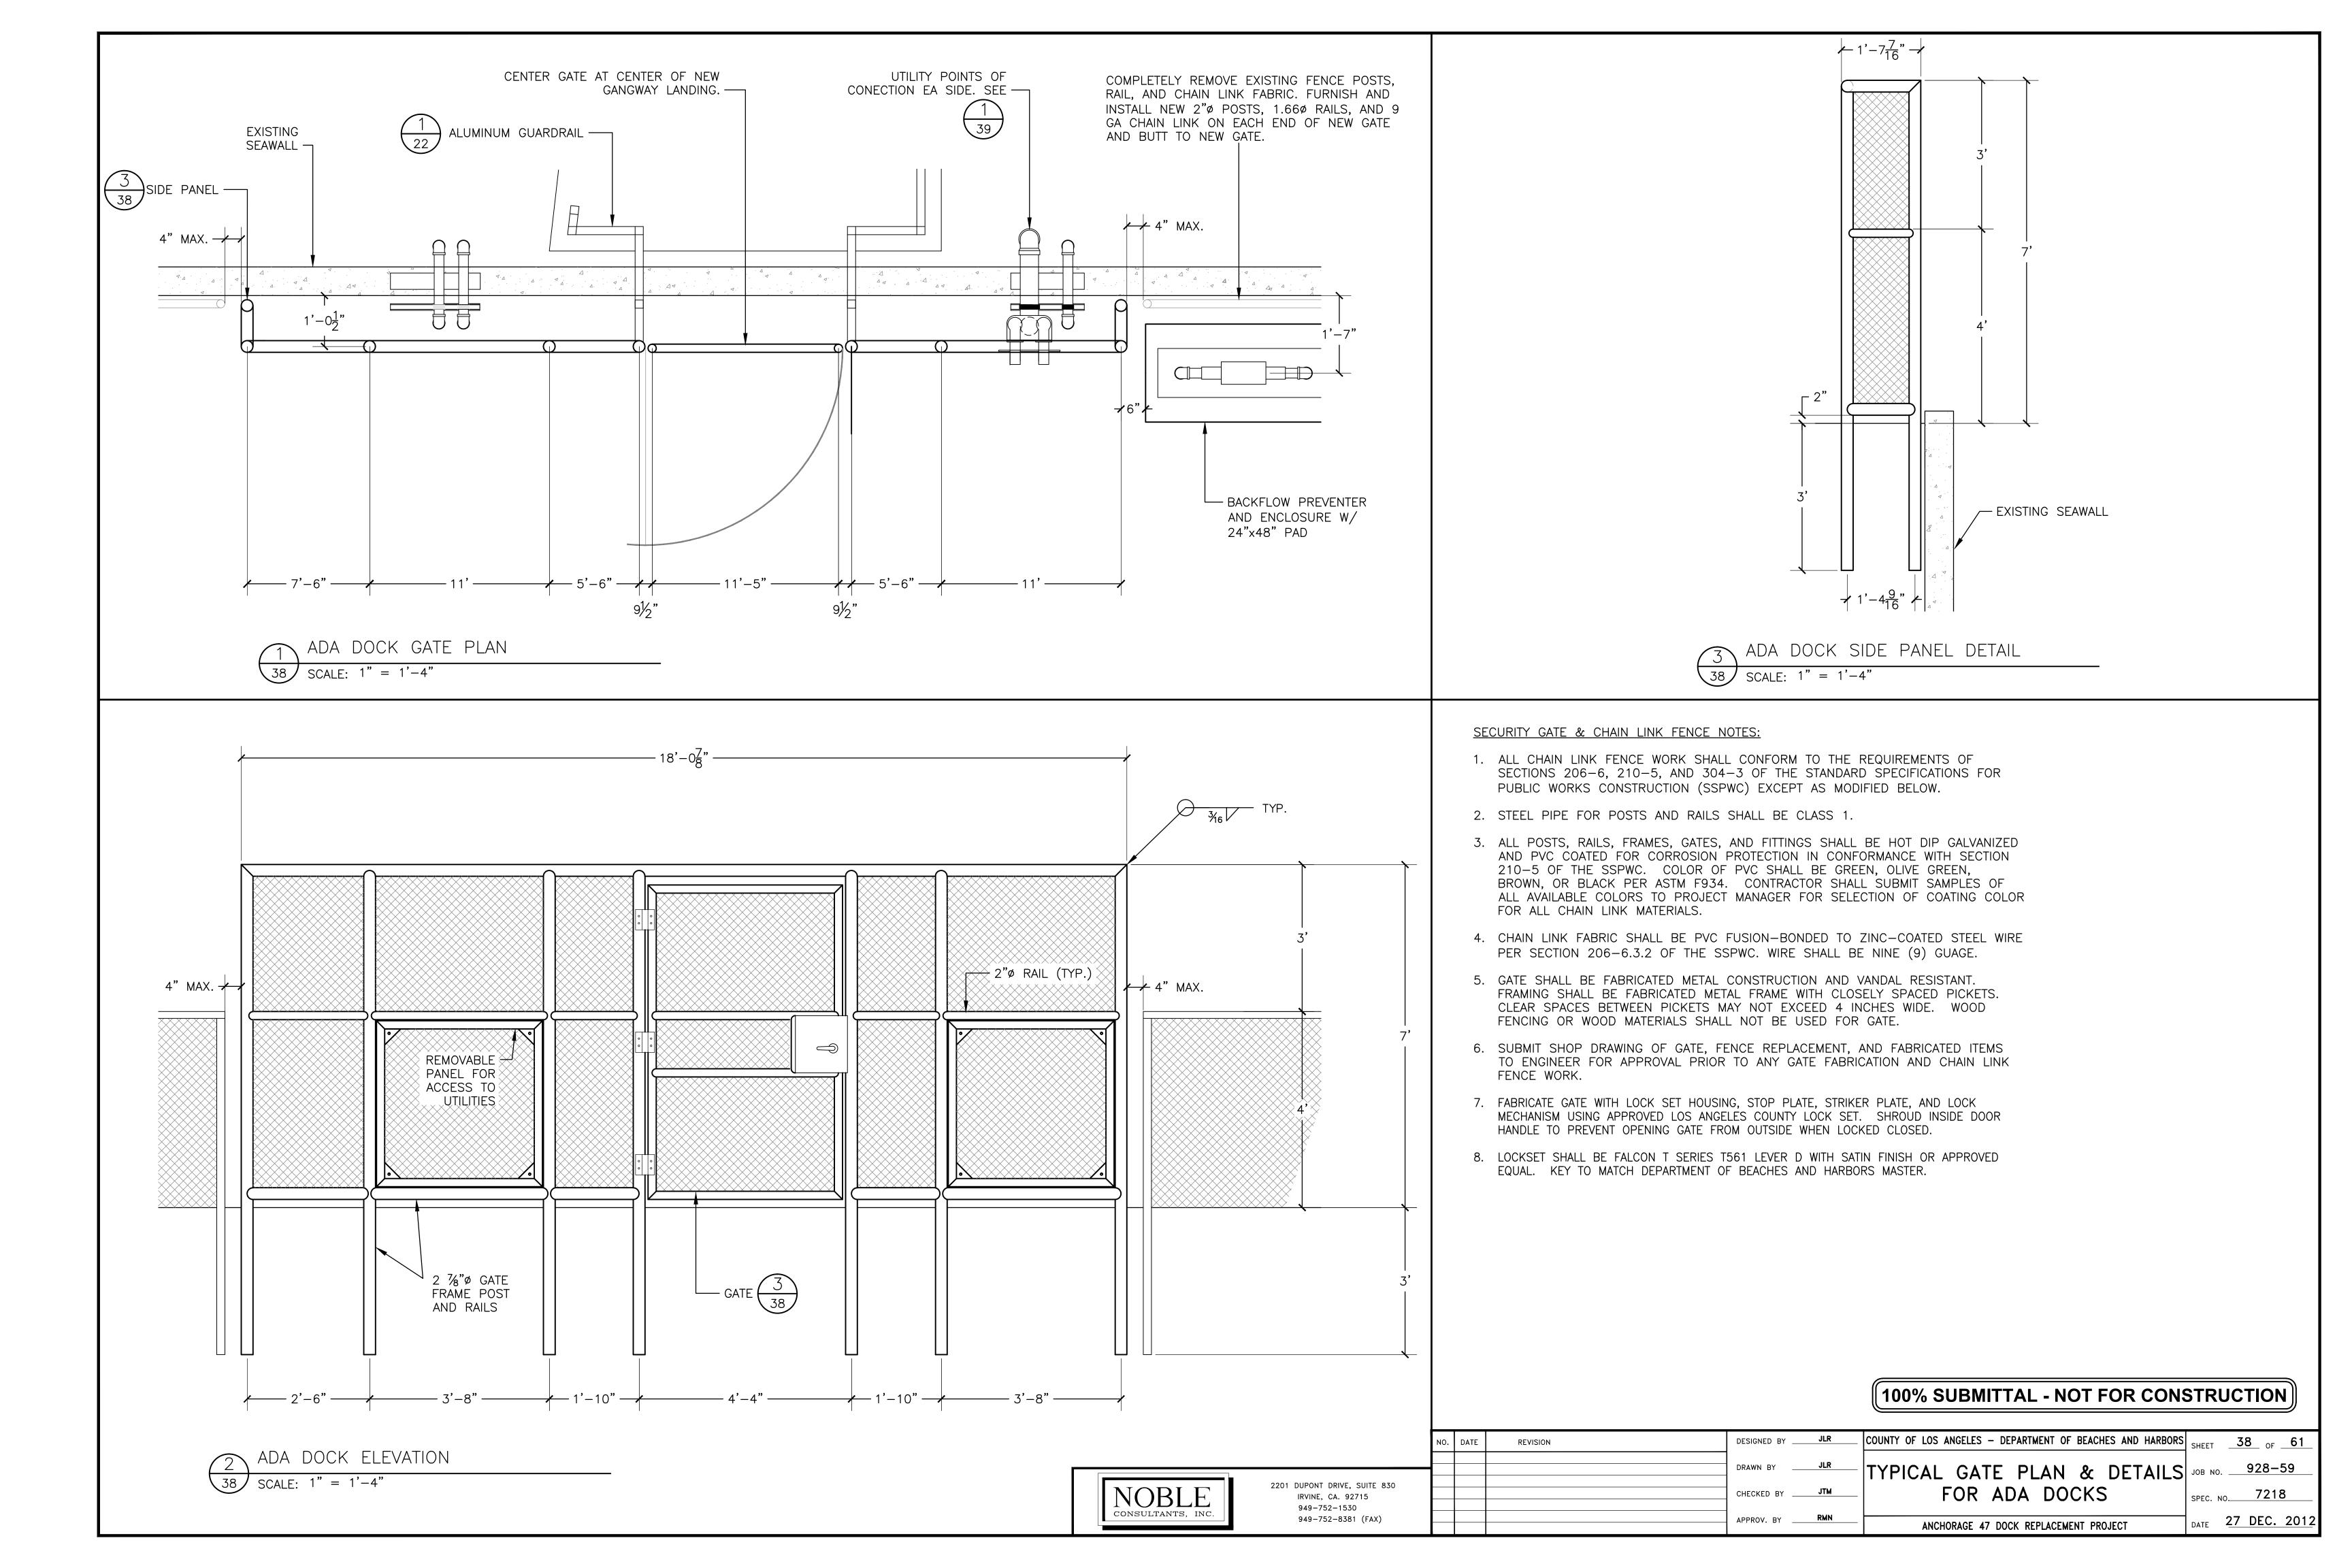

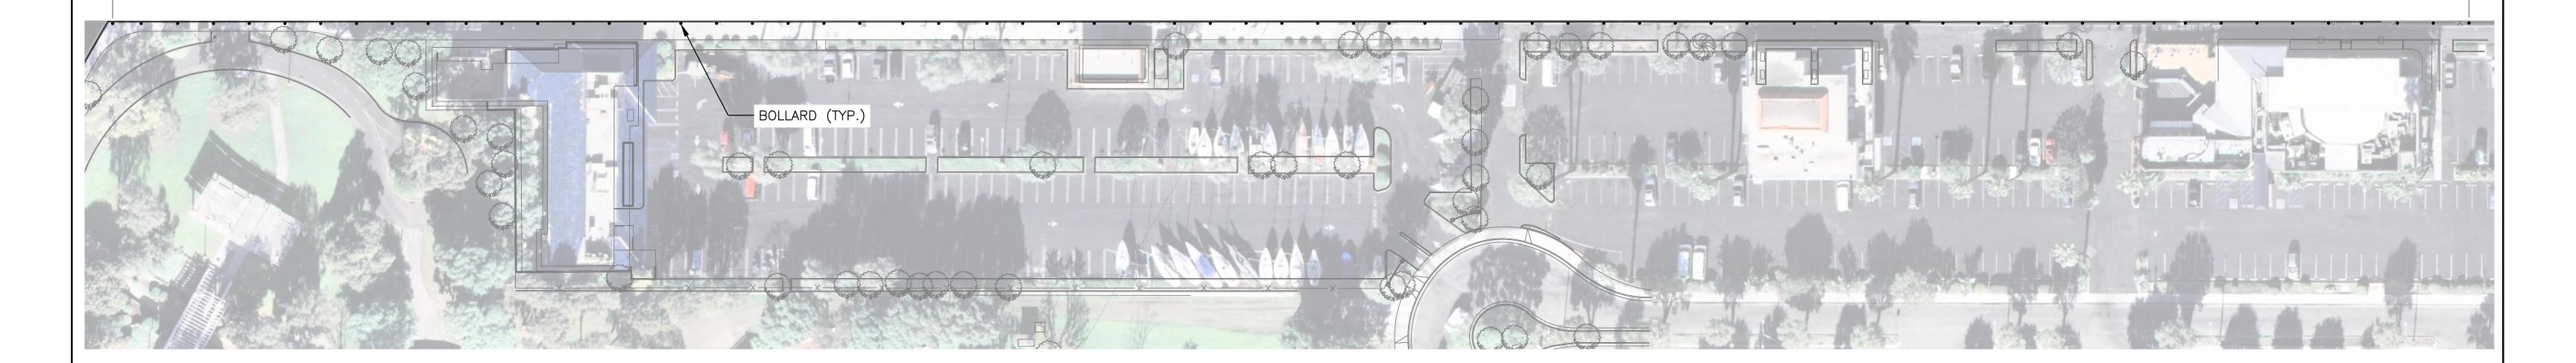

LIGHT BOLLARD NOTES:

- 1. LIGHT BOLLARD SHALL BE VRB1 LED, TYPE III, VANDAL-RESISTANT ROUND BOLLARD MANUFACTURED BY KIM LIGHTING. (SEE SHEET 2 FOR SPECIFICATIONS)
- 2. LIGHT BOLLARD SHALL BE UL LISTED AND SUITABLE FOR WET LOCATIONS.
- 3. LIGHT BOLLARD SHALL HAVE 15 LEDS PER BOLLARD.
- 4. LIGHT BOLLARD SHALL HAVE COLOR TEMPERATURE 5100K.
- 5. LIGHT BOLLARD SHALL HAVE DOME TOP CAP AND COLOR SHALL MATCH PROPOSED FENCE COLOR.

BURTON CHACE PARK, MARINA DEL REY
BOLLARD LIGHTING PLAN


SCALE: 1" = 40'




NO	DATE	REVISION	DESIGNED BYJLR	COUNTY OF LOS ANGELES - DEPARTMENT OF BEACHES AND HARBORS	SHEET 1 OF 2
+			DRAWN BY JLR		JOB NO. 928-59
			CHECKED BY RMN	BOLLARD LIGHTING PLAN	SPEC. NO. AS SHOWN
			APPROV. BY RMN	CHACE PARK ANCHORAGE 47 DOCK REPLACEMENT	DATE 23 JAN. 2013

NOBLE CONSULTANTS, INC.

2201 DUPONT DRIVE, SUITE 830 IRVINE, CA. 92715 949-752-1530 949-752-8381 (FAX)

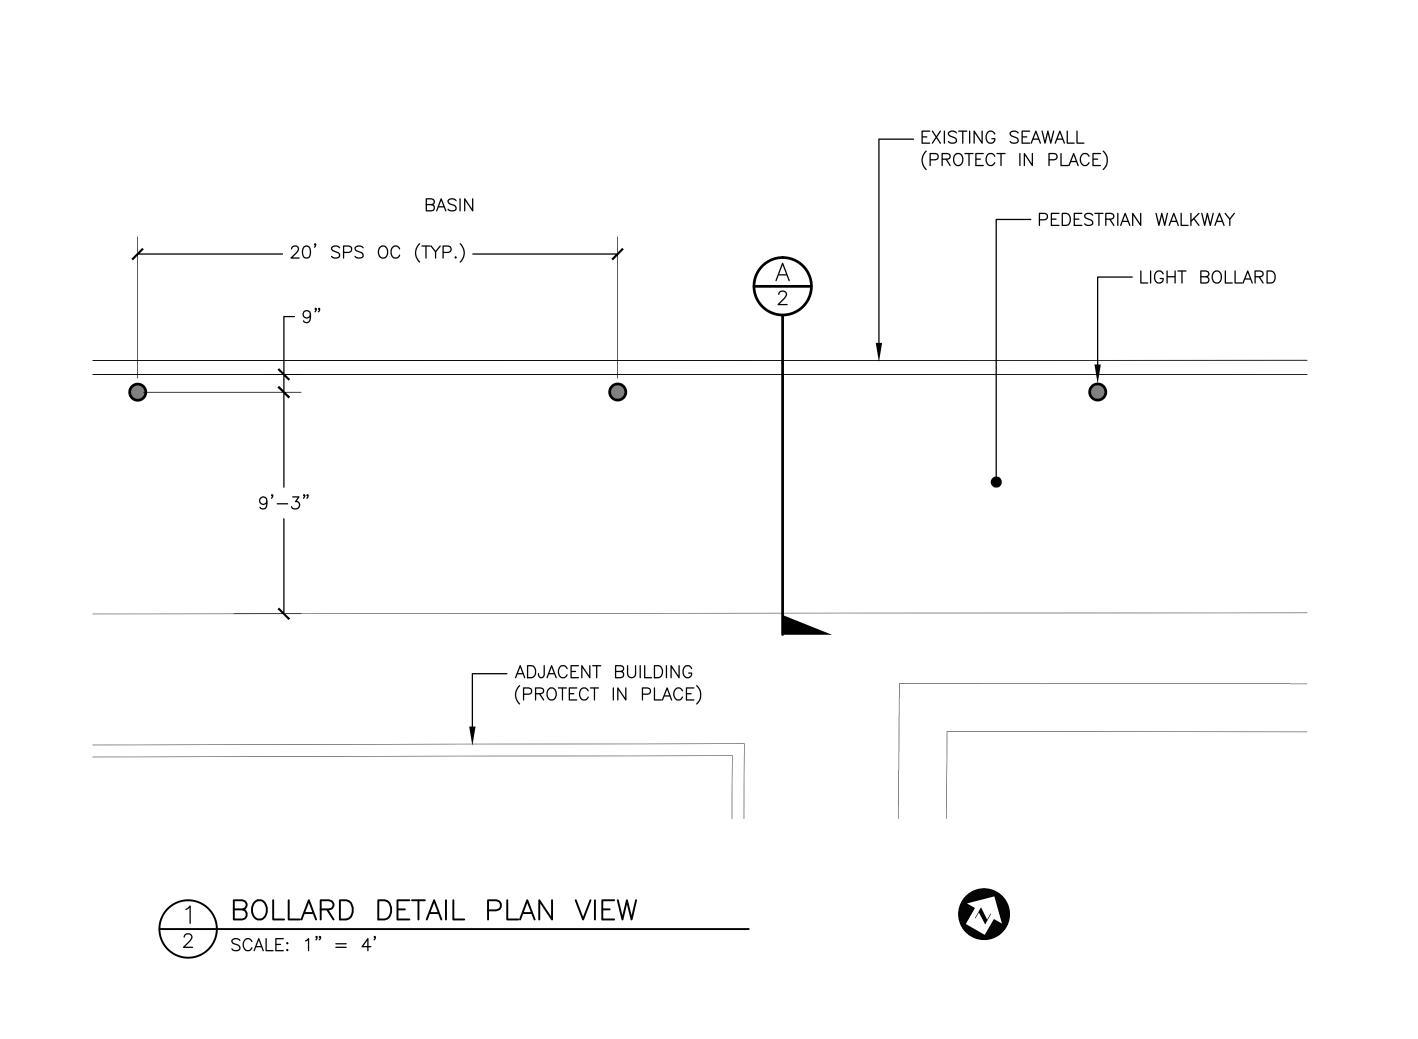

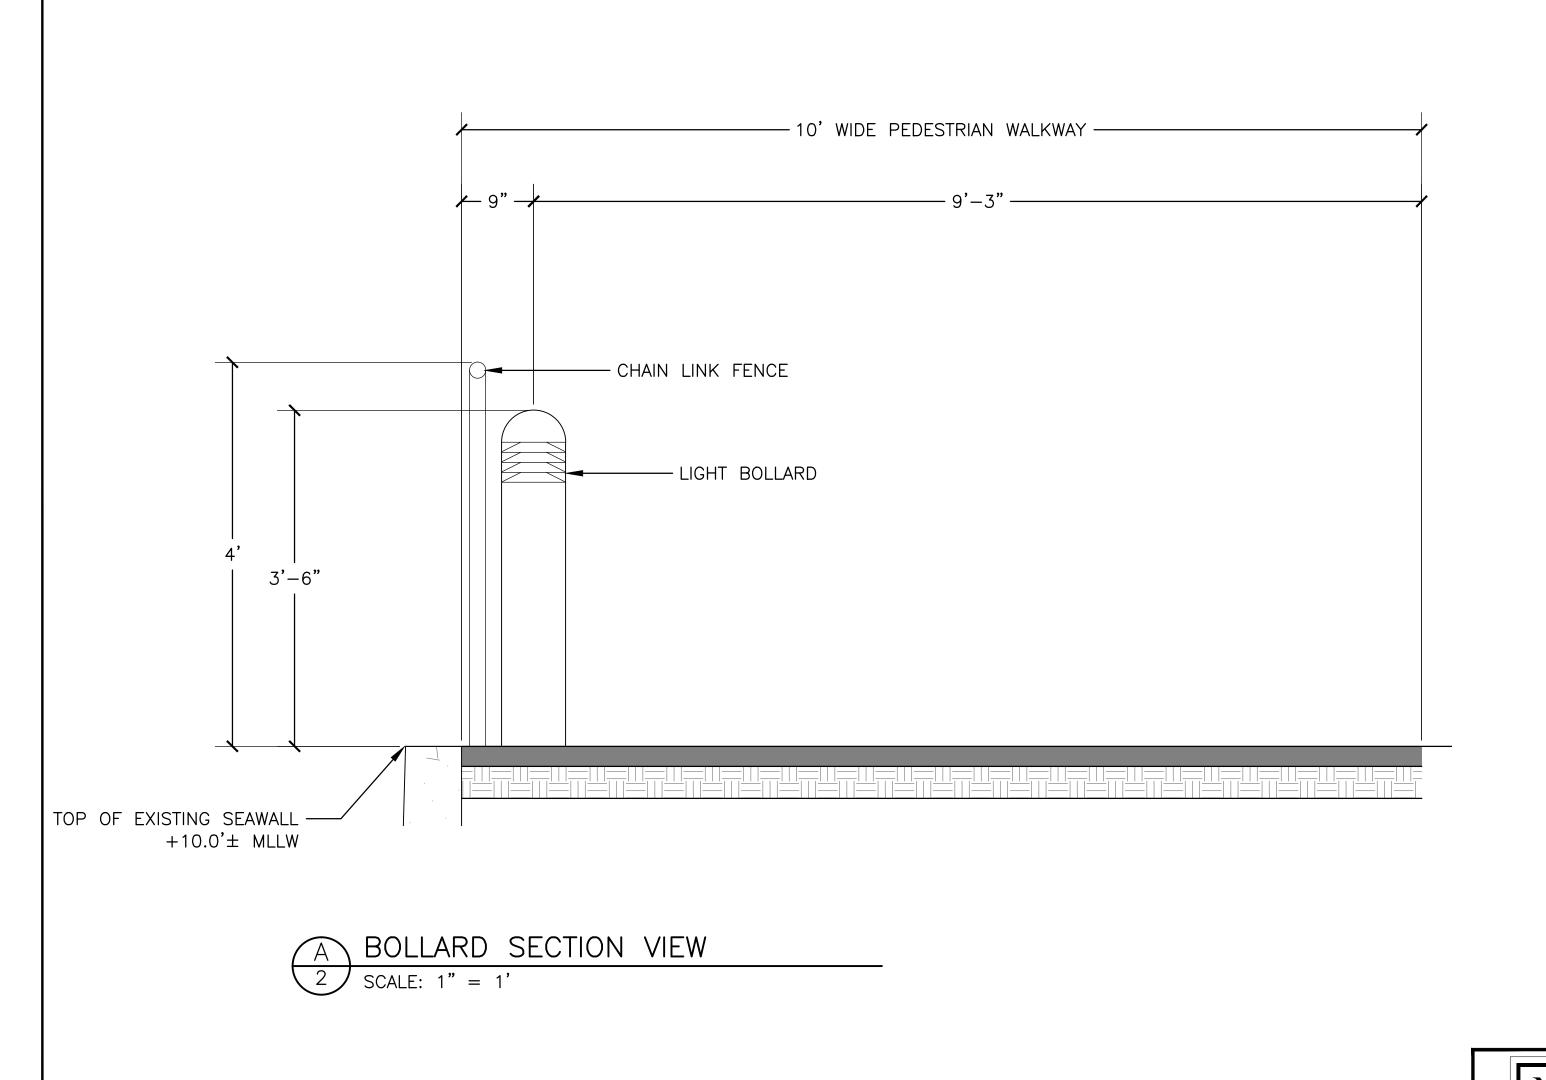



VRB1 LED Round Bollard

Single Function, Vandal-Resistant, Aluminum Shaft

revision 6/29/11 • kl_vrb1led_spec.pdf

Approvals:

Catalog number:

Type:

Job:


Fixture Electrical Module Luminaire Finish Option (includes top cap and shaft)
See page 2

Date: Page: 1 of 2

Specifications

VRB-LED Models 10 - 20 Diodes

VRB1- Single Function Luminaire (Aluminum Shaft)
Maximum weight: 30 lb

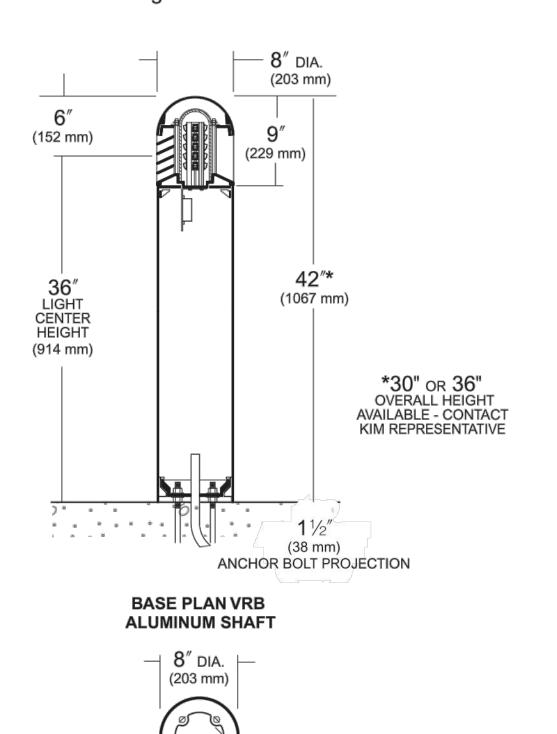

— 3^{3} /4" CONDUIT OPENING

∠5" BOLT CIRCLE DIA.

Domed Top Cap: One-piece die-cast aluminum secured to louvers by concealed allen screws in keyhole slots. For relamping access, allen screws shall not require complete removal.

Louvers: Aluminum die-cast with vertical support ribs at 90° intervals. Horizontal louver blades shall have a 1¾″ depth, a 65° upward pitch and provide light source cutoff above horizontal. Louver assembly shall be secured to shaft by four internal tie rods.

Lamp Enclosure: One-piece tempered molded glass with internal flutes and full gasketing at bottom edge.

Fixture Head: Allows flow-through ventilation around and above the lamp enclosure.

Shaft: One-piece extruded aluminum, .125" wall thickness with a heavy cast aluminum twist-lock anchor base concealed within the shaft. Concealed set screws shall lock shaft onto the cast anchor base.

Electronic Module: All electrical components are either UL or ETL recognized, mounted on a single plate and factory prewired with quick disconnect plugs. Driver is rated for -40°F starting and has a 0-10V dimming interface for multi-level illumination options.

Optical Module: Each LED equipped with a directional optic for maximum beam angle projecting through louver stack spacings. LED boards to be mounted to an anodized interlocking heat sink extrusion. (Type I) two 5-LED boards for a total of 10-LED. (Type III) three 5-LED boards for a total of 15-LED. (Type V) four 5-LED boards for a total of 20-LED. Available in 3500K and 5100K color temperatures.

Anchor Bolts: Four 3/8'' x 10'' + 2'' zinc plated L-hooks, each with two nuts, washers and a rigid pressed board template.

Finish: TGIC thermoset polyester powder coat paint, 2.5 mil nominal thickness, applied over a titanated zirconium conversion coating; 2500 hour salt spray test endurance rating. Standard colors are Black, Dark Bronze, Light Gray, Stealth Gray™, Platinum Silver, or White. Custom colors are available.

CAUTION: Fixtures must be grounded in accordance with national, state and/or local codes. Failure to do so may result in serious personal injury.

Listings and Ratings					
UL, or ETL to UL Star	25C Ambient				
IP46 Rated	FS = Fully Shielded ²	-			

¹Suitable for wet locations.

²Dark Sky Legislation Compliant

KIM LIGHTING RESERVES THE RIGHT TO CHANGE SPECIFICATIONS WITHOUT NOTICE

© 2011 KIM LIGHTING P.O. BOX 60080, CITY OF INDUSTRY, CA 91716-0080 • TEL: 626/968-5666 • FAX: 626/369-2695




		NO.	DATE	REVISION	DESIGNED BY	COUNTY OF LOS ANGELES - DEPARTMENT OF BEACHES AND HARBORS	SHEET		<u>2</u> o	F	
		\blacksquare			DRAWN BYJLR		JOB N	10	928-	-59	_
NOBLE	2201 DUPONT DRIVE, SUITE 830 IRVINE, CA. 92715				CHECKED BY RMN	BOLLARD DETAILS	SPEC.	NO/	12 SI	HOWN	
CONSULTANTS, INC.	949-752-1530 949-752-8381 (FAX)		+		APPROV. BY RMN	CHACE PARK ANCHORAGE 47 DOCK REPLACEMENT	DATE	23	JAN	l. 201	_3



PROJECT: 928-59

Anchorage 47 Dock Replacement Marina del Ry, (A Project No.:

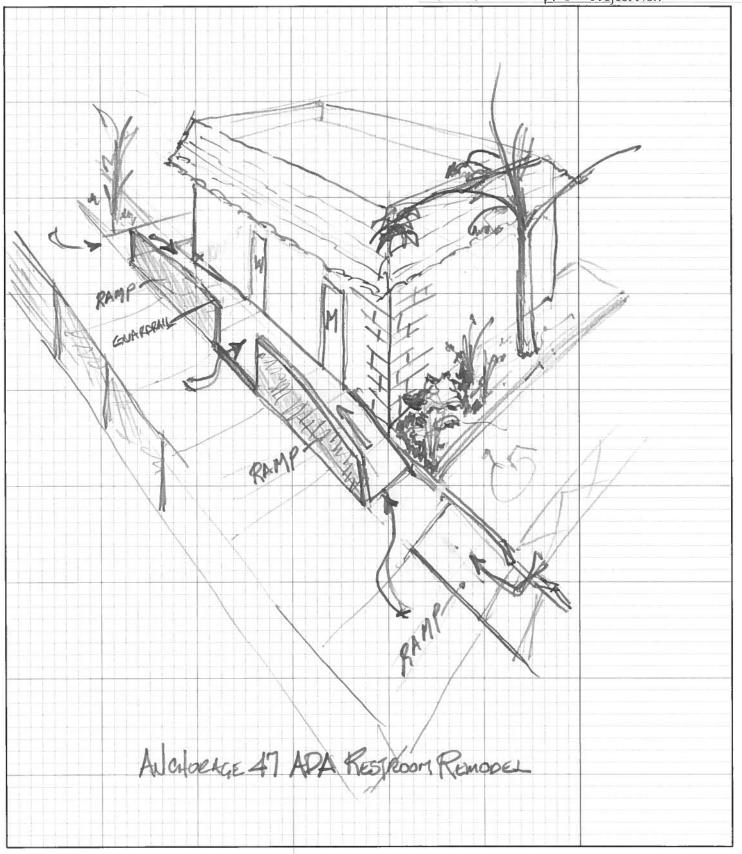

Ву:	Checker:	Sheet:
Date:	Date:	of